



ELEVATION A-A
SCALE 1:500

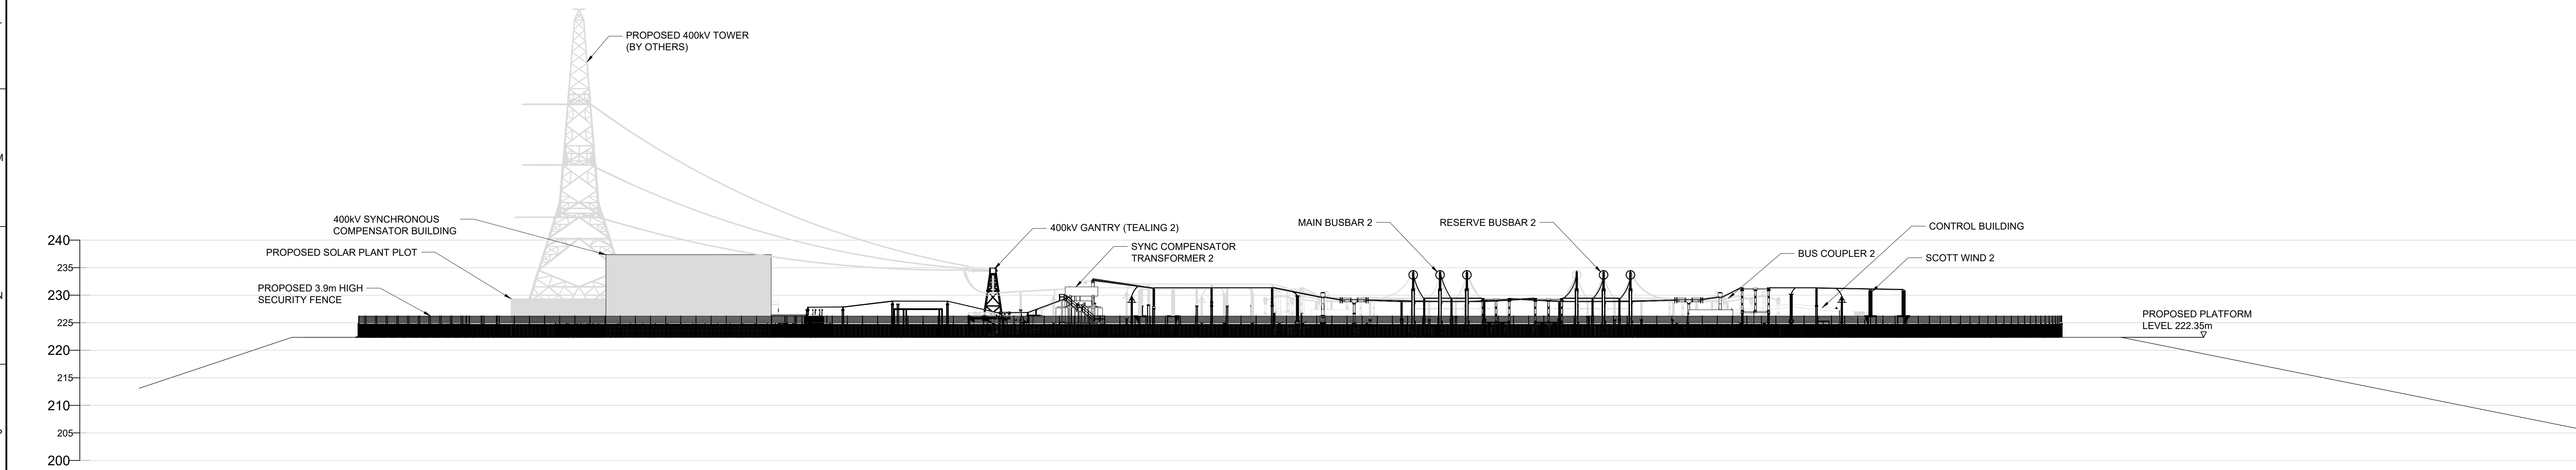

ELEVATION B-B
SCALE 1:500

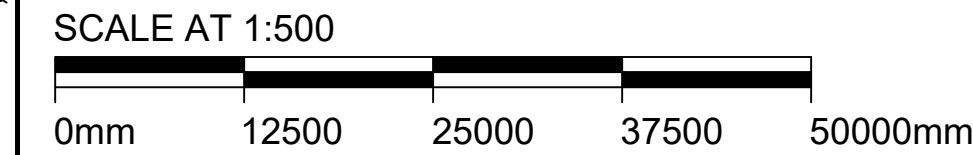

Issue / Revision:	P01	Drawn By:	CN	Issue / Revision:	P02	Drawn By:	CN
Investment No.:		Checked By:	RC	Investment No.:		Checked By:	SD
Date:	21/NOV/24	Approved By:	PM	Date:	10/APR/25	Approved By:	
Description / Remarks ISSUED FOR PLANNING				Description / Remarks UPDATED KEY PLAN FOR SECTION E-E			

NOTES:

- DO NOT SCALE FROM THIS DRAWING. USE ONLY SPECIFIED DIMENSIONS.
- ALL LEVELS ARE IN METRES TO ORDNANCE DATUM UNLESS NOTED OTHERWISE.


REFERENCE DRAWINGS:

162507-BMD-CE-HR-DSE-TP-0001
162507-BMD-PL-HR-DPL-TP-0001

PLATFORM EARTHWORKS LAYOUT
ELECTRICAL LAYOUT

LEGEND:

--- EXISTING TERRAIN

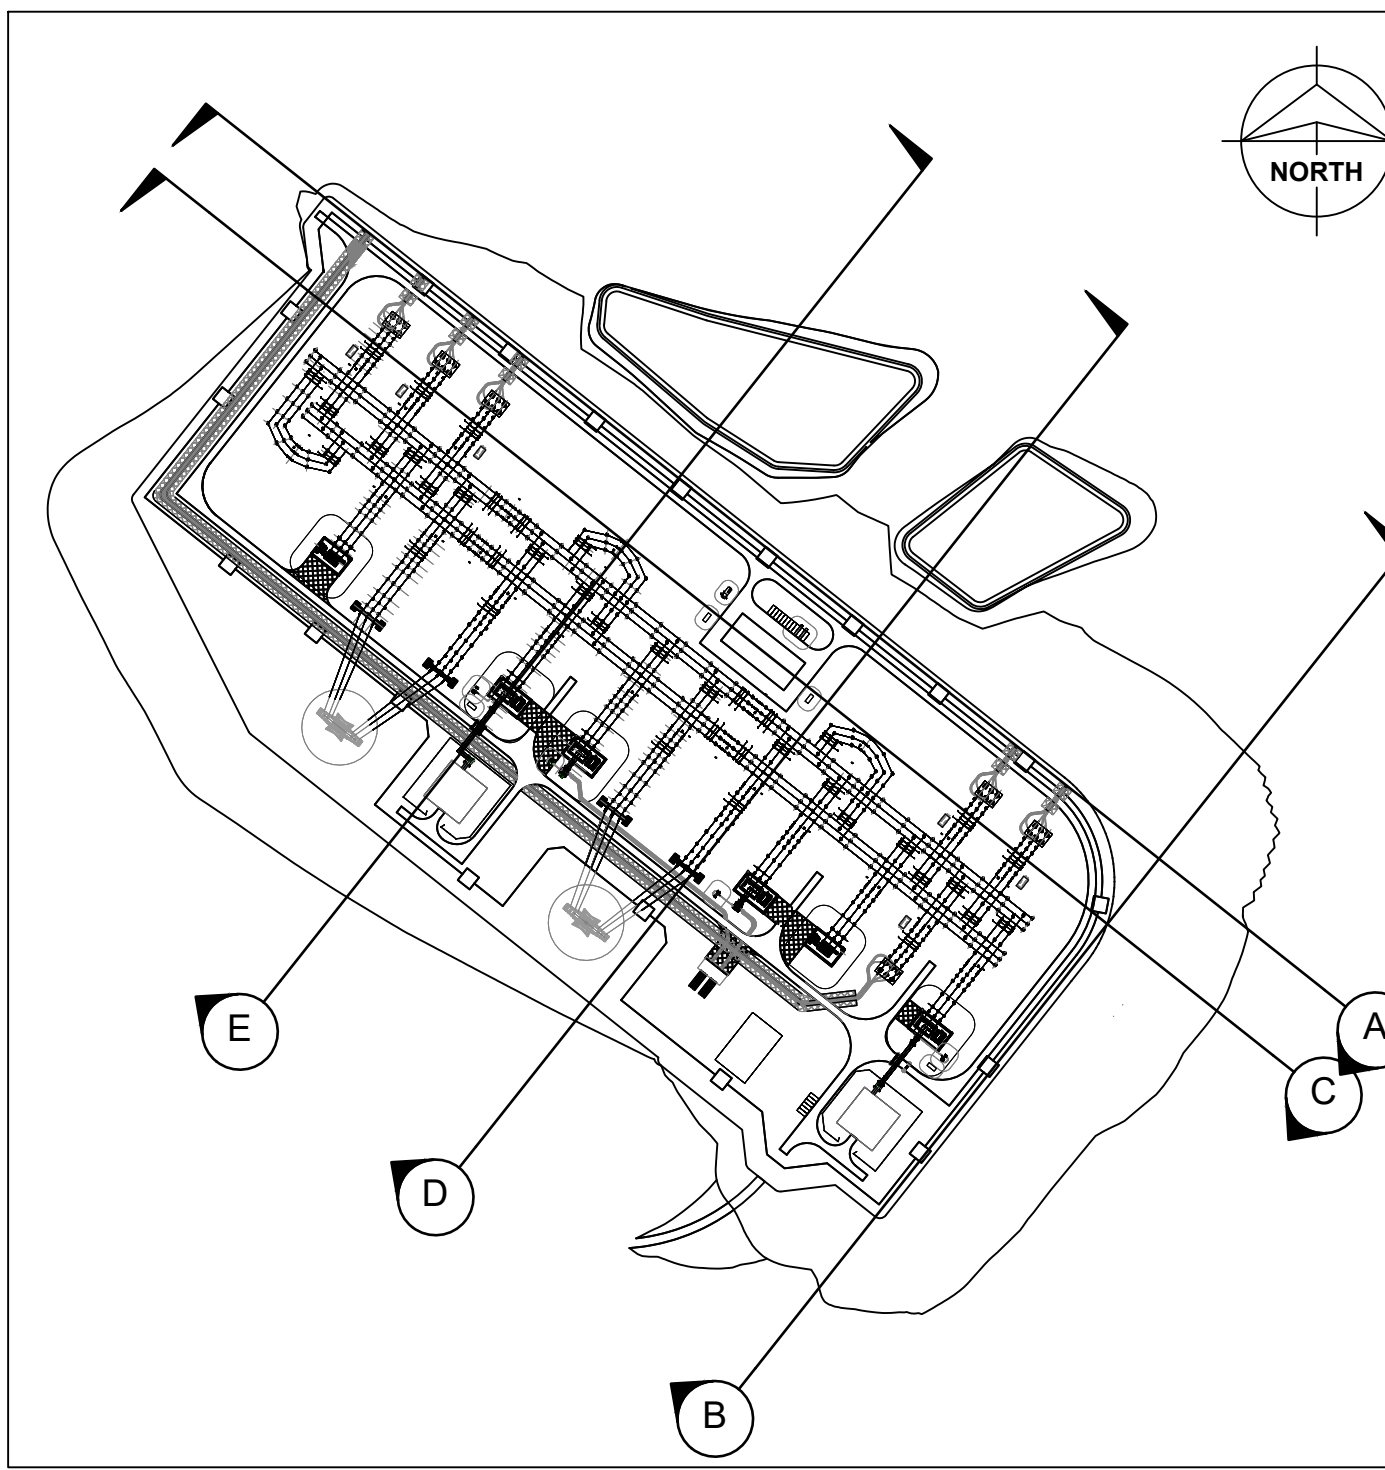

KEY PLAN
SCALE 1:5000

Drawing Status:			
FOR PLANNING			
Software:	Status Code:	Scale:	Paper Size:
AUTOCAD	Not Used	1:500	A0
Drawn By:	Checked By:	Approved By:	Date:
CN	RC	PM	21/NOV/24

Contractor:	
BURNS & McDONNELL	
<small>Burns & McDonnell Europe (UK) Limited, trading as Burns & McDonnell 2 Parkside Way, Moorn Park, Motherwell, ML1 4QR, UK Email: info@burns-mcd.com Website: www.burnsmcd.com</small>	

Client:	Supplier / Subcontractor:

Drawing Title:
SITE ELEVATIONS

Project Name:
HURLIE 400kV SUBSTATION

Site Name:
HURLIE 400kV SUBSTATION

Contractor Drawing No.:
162507-BMD-CE-HR-DEL-TP-0003

Client Drawing No.:	Sheet:
162507-BMD-CE-HR-DEL-TP-0003	01
Supplier / Subcontractor Drawing No.:	Next:
-	02
Issue / Revision:	
P02	