



TYPICAL SuDS ATTENUATION AND TREATMENT BASIN
SCALE 1:100

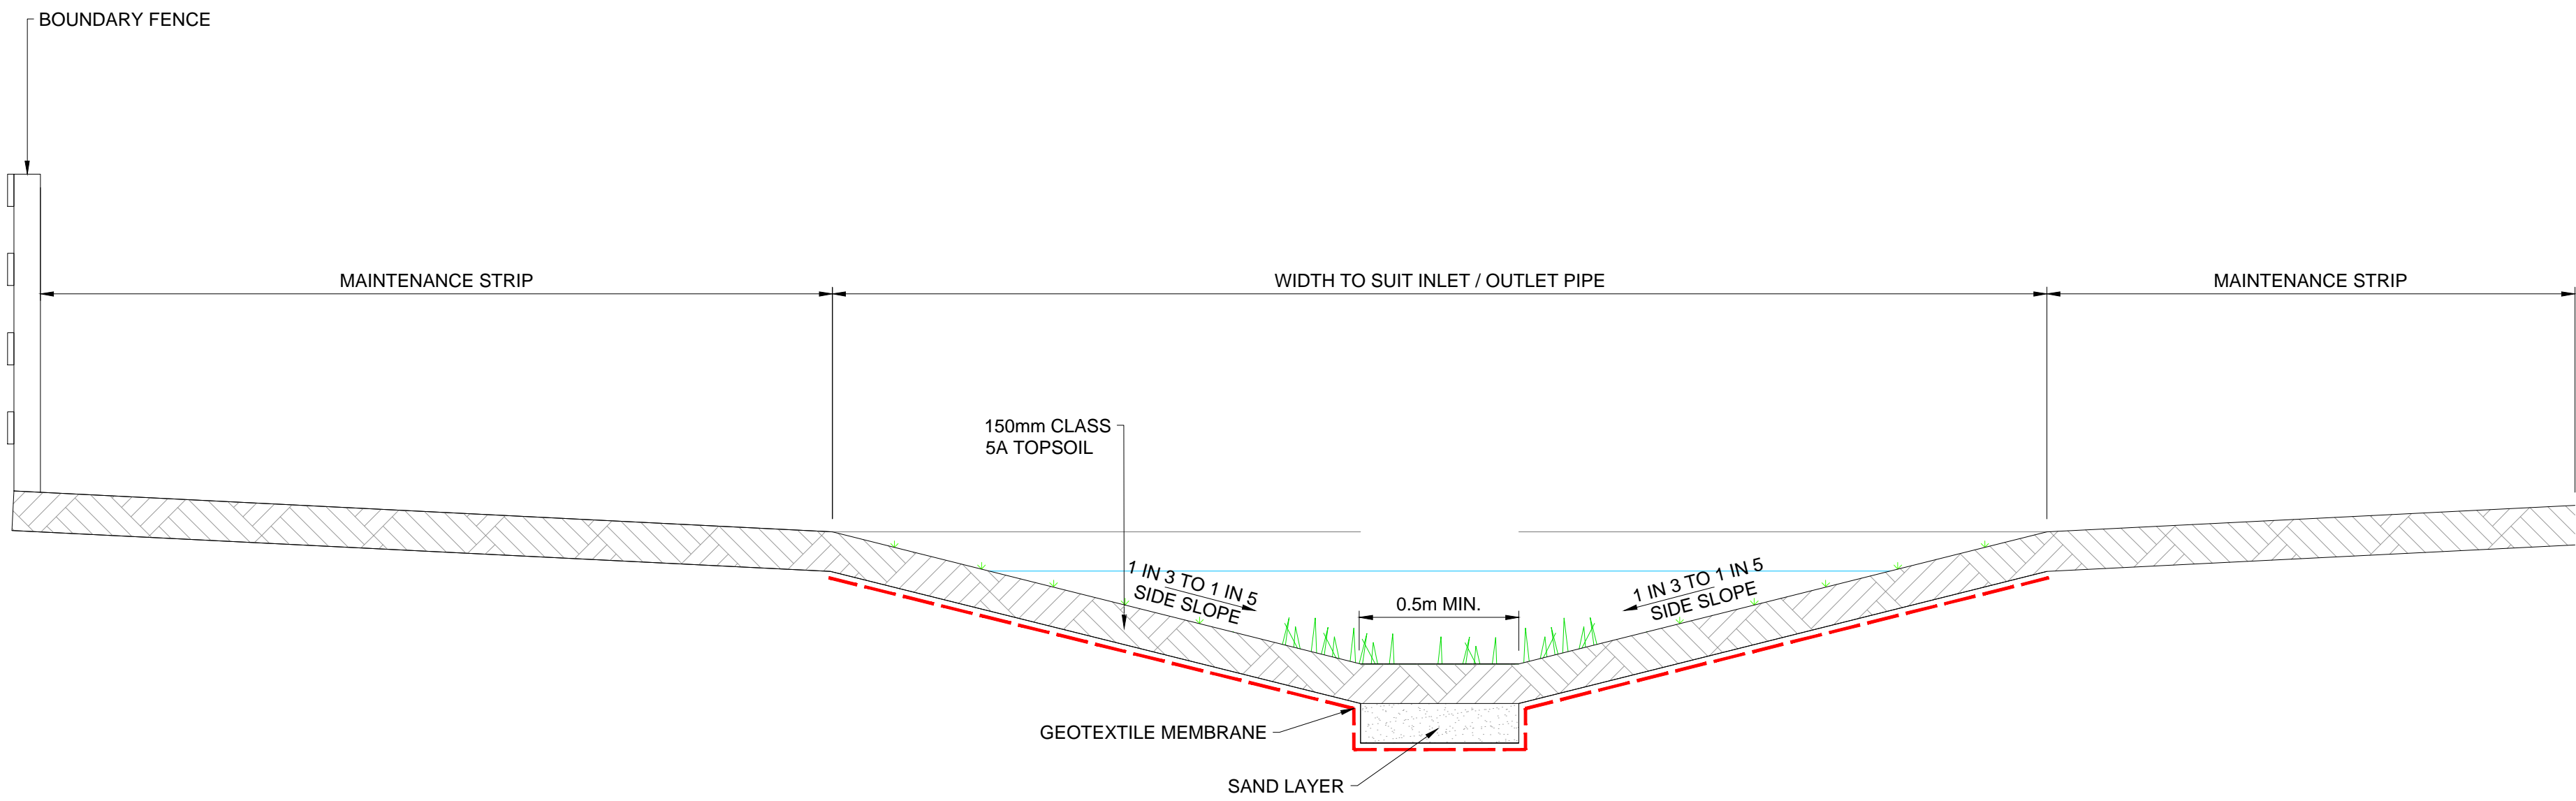

TYPICAL WET SWALE
SCALE 1:20m

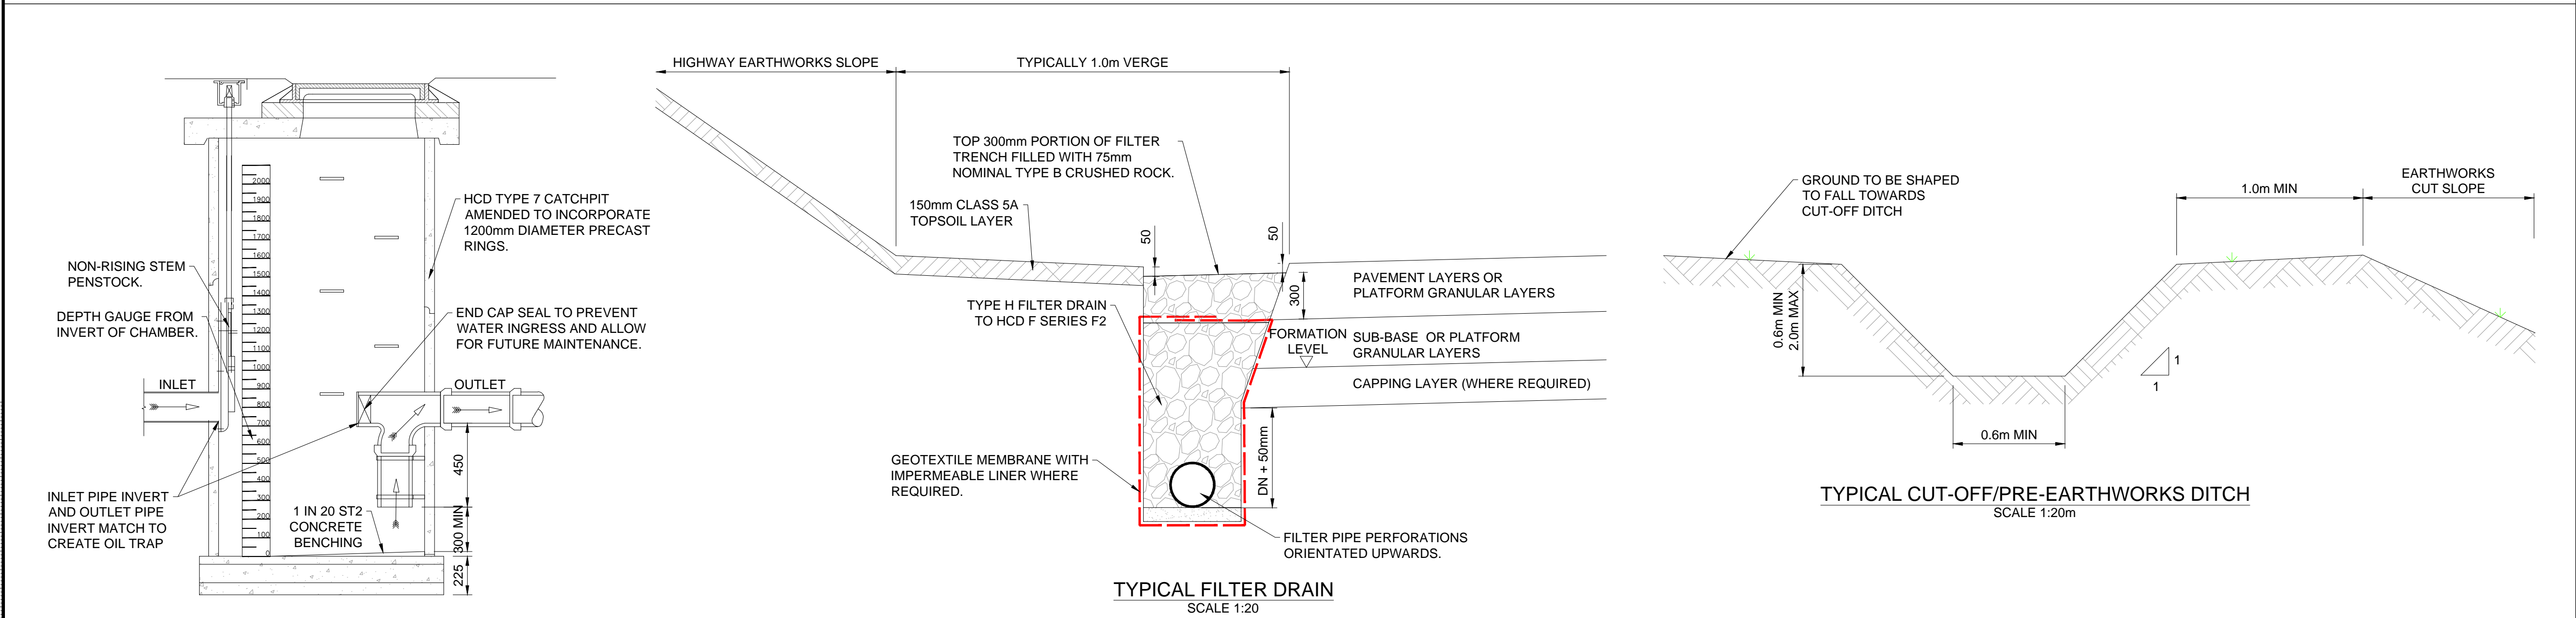

TYPICAL POLLUTION CONTROL
CHAMBER
SCALE 1:20

TYPICAL FILTER DRAIN
SCALE 1:20

TYPICAL CUT-OFF/PRE-EARTHWORKS DITCH
SCALE 1:20m

NOTES

- DO NOT SCALE FROM THIS DRAWING MANUALLY OR ELECTRONICALLY.
- THIS DRAWING IS TO BE READ IN CONJUNCTION WITH ALL OTHER RELEVANT PROJECT INFORMATION.
- ALL DATUM LEVELS ARE IN METRES AND DIMENSIONS ARE IN METRES UNLESS OTHERWISE STATED.
- ALL SLOPES AND EMBANKMENTS SHOWN ON THIS DRAWING FALL OR RISE AT 1 IN 3 UNLESS OTHERWISE NOTED ON THE SPECIFIC DETAIL.
- REFER TO DRAWINGS LT459-SWE-XX-XX-D-X-0501 AND LT459-SWE-XX-XX-D-X-0502 FOR THE DRAINAGE LAYOUT.

KEY TO DRAWING

P04	20/08/2024	FINAL ISSUE	RL	SG	CB
P03	18/04/2024	DESIGN FIX 2C	RL	SG	CB
P02	05/03/2024	DESIGN FIX 2B	RL	SG	CB
P01	15/12/2023	DESIGN FIX A	RL	SG	CB
Rev	Date	Amendment Details	Dr'n	Chk'	App'

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SWECO

Client



Project Title

**FANELLAN
400kV SWITCHING STATION AND
HVDC CONVERTOR STATION**

Drawing Title

**TYPICAL DRAINAGE DETAILS
SHEET 1 OF 1**

Purpose Of Issue

PRELIMINARY

Status	S5				FOR REVIEW AND ACCEPTANCE						
Drawn	RL		Designed	RL		Checked	SG		Approved	CB	
Sheet Size	A1		Scale	AS SHOWN		Sweco Ref	65209842		Revision	P04	

Drawing Number

LT459-SWE-XX-XX-D-X-0503